



SCALE: 1/4"=1'-0"

KEYNOTES:

- 1) UTILIZE EXISTING CONDUITS.
- PROVIDE AND INSTALL VFD/DISCONNECT FOR COOLING TOWER MOTOR. PROVIDE AND INSTALL WIRING FROM MOTOR TO VFD AND FROM VFD TO MCC.
- 3 REUSE EXISTING CKT AND CONDUIT. PROVIDE NEW WIRING.

SHEET NOTES:


- 1. PROVIDE FILTERS FOR VFD'S AS REQUIRED.
- 2. ALL WIRING FOR VFD'S SHALL BE VFD RATED CABLES.
- 3. THE COOLING TOWER IS ON THE ROOF OF THE CHILLER PLANT DIRECTLY ABOVE THE CHILLER. THE CHILLER ROOF FLOOR IS 25' ABOVE THE CHILLER ROOM







State of Maryland Professional Certification. I hereby certify that these documents were prepared or **approved** by me, and that I am a duly licensed professional engineer under the laws of the State of Maryland, License No. 024687, Expiration Date: 03/15/2020

DESIGNED B. IDILBI 09/30/17	NUMBER	REFERENCE DRAWINGS TITLE		IUM	REVISIONS DESCRIPTION	WASHINGTO	NV	/IETROP(OLITAN	I AREA TRANSIT AUTHO	RITY	ANI	D COOLING TO		NT OF CHILLERS JES AT EIGHT METRO-RA	All STATIONS
DATE DRAWN J. ZHU 09/30/17 DATE CHECKED D. KHAN 03/23/18			03/30/2018	0 FINAL	L CONTRACT DRAWINGS					ONSTRUCTION SERVICES NEWAL PROGRAM GROUP		7***	D 000210 10	CWPG2 - CAPIT	OL HEIGHTS (G02) LAN - NEW WORK	
DATE						 PROVED MANK H. 1712 RIKIMAGNUSSEN NAGER, ENV. PLANNING AND COMP	gjwos	03/2018 DATE		APPROVED GRAHAM SPILLER GFP DEPUTY PROGRAM MANAGER	03/2018 DATE	— м NO. М1304	CONTRACT NO. FQ-18102	SCALE 1/4"=1'-0"	DRAWING NO. CWPG2-E-103	SHEET NO. 127 of 173

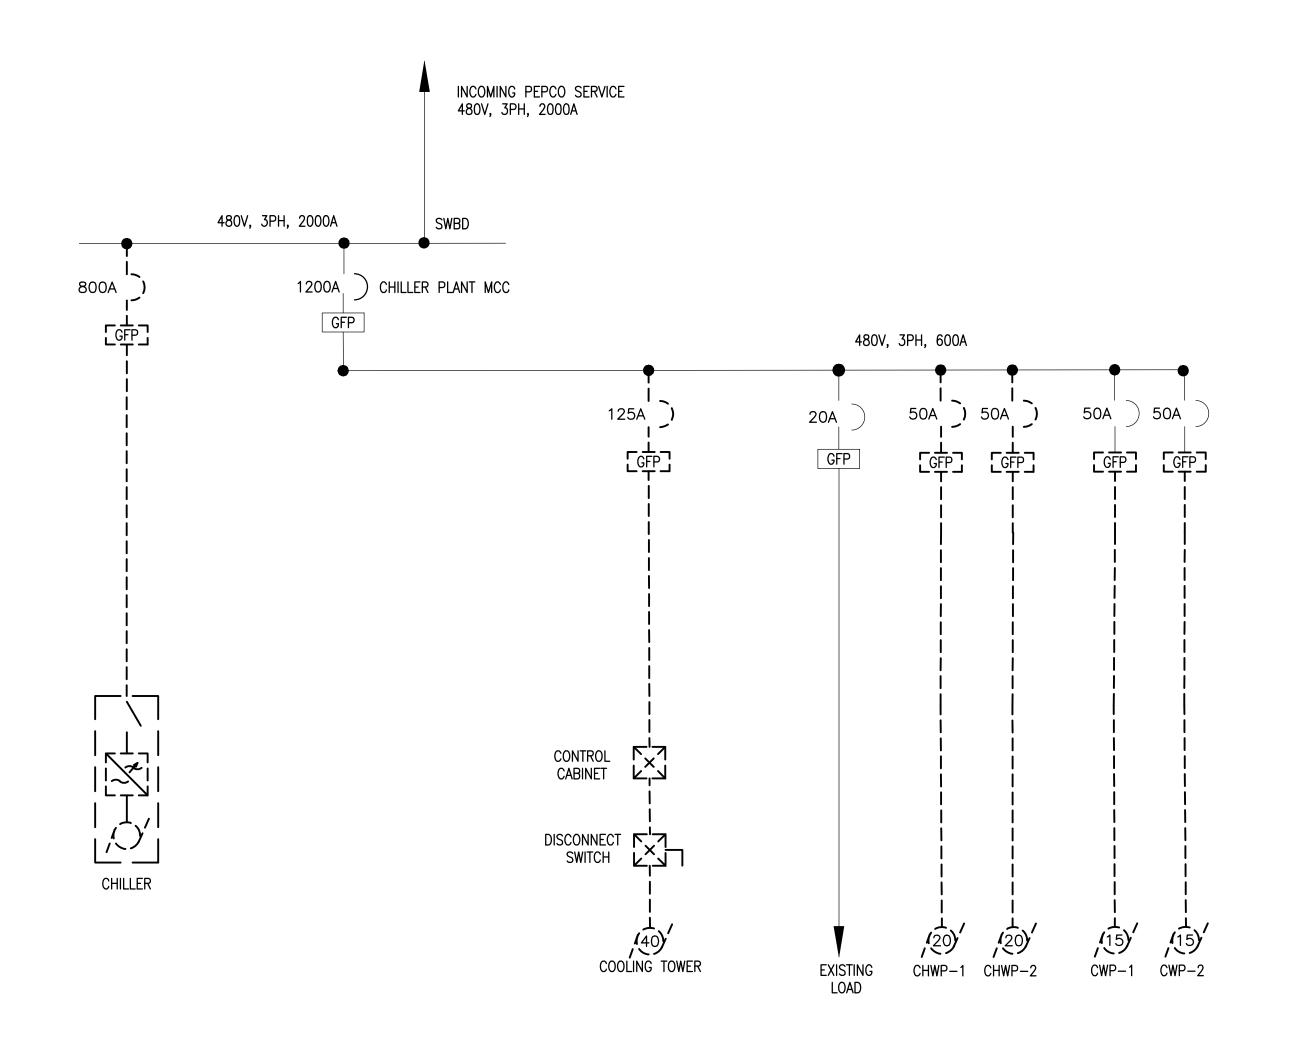

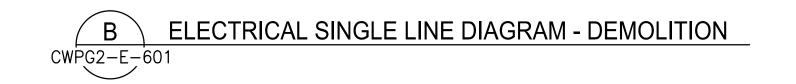

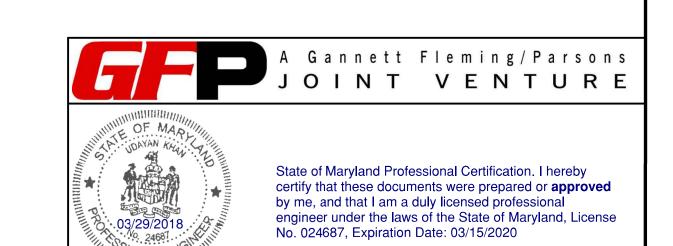

			REFERENCE DRAWINGS		REVISIONS	M WASHINGTON	I METROPOLITA	N AREA TRANSIT AUTHO	NRITY		
DESIGNED B. IDILBI	09/30/17	NUMBER	TITLE	DATE	NUM DESCRIPTION	WASHINGTON	I WE INOI OLITA	IN AILA ITANOII AUTIC	/	ΔΝΙΓ	D C
DESIGNED DESIGNED	DATE			03/30/201	18 0 FINAL CONTRACT DRAWINGS		OF DECION AND	CONCEDUCATION CEDVICES			<i>y</i> 00
DRAWN J. ZHU	09/30/17					DEPARTMENT	OF DESIGN AND C	CONSTRUCTION SERVICES			
	DATE					OFFICE OF INFE	RASTRUCTURE RE	ENEWAL PROGRAM GROUP			
CHECKED <u>D. KHAN</u>	03/23/18 DATE					11 Mars					
	DATE					APPROVED Mark A. 18gm	03/2018	APPROVED Me Alle	03/2018	M NO.	cc
						MARK MAGNUSSEN	DATE	GRAHAM SPILLER	DATE	M1304	FC
						MANAGER, ENV. PLANNING AND COMP		GFP DEPUTY PROGRAM MANAGER			' `

REPLACEMENT OF CHILLERS
AND COOLING TOWER ACCESSORIES AT EIGHT METRO-RAIL STATIONS
CWPG2 - CAPITOL HEIGHTS (G02)
ELECTRICAL SINGLE LINE DIAGRAM - DEMOLITION

SHEET NOTES:

1. ALL SHOWN EQUIPMENT IS EXISTING TO REMAIN

2. REMOVE AND DISPOSE OF DEMOLISHED EQUIPMENT

3. FOR EQUIPMENT TO BE DEMOLISHED: ALL EXISTING


BE REQUESTED FROM WMATA ENGINEER.

CONDUIT AND WIRING SHALL BE REMOVED. PERMISSION TO USE EXISTING CONDUIT (WIRES REMOVED) SHALL

UNLESS SHOWN OTHERWISE.


ALONG WITH ASSOCIATED WIRING.

١٥.	CONTRACT NO.	SCALE	DRAWING NO.	SHEET NO.
304	FQ-18102	AS NOTED	CWPG2-E-601	128 of 173

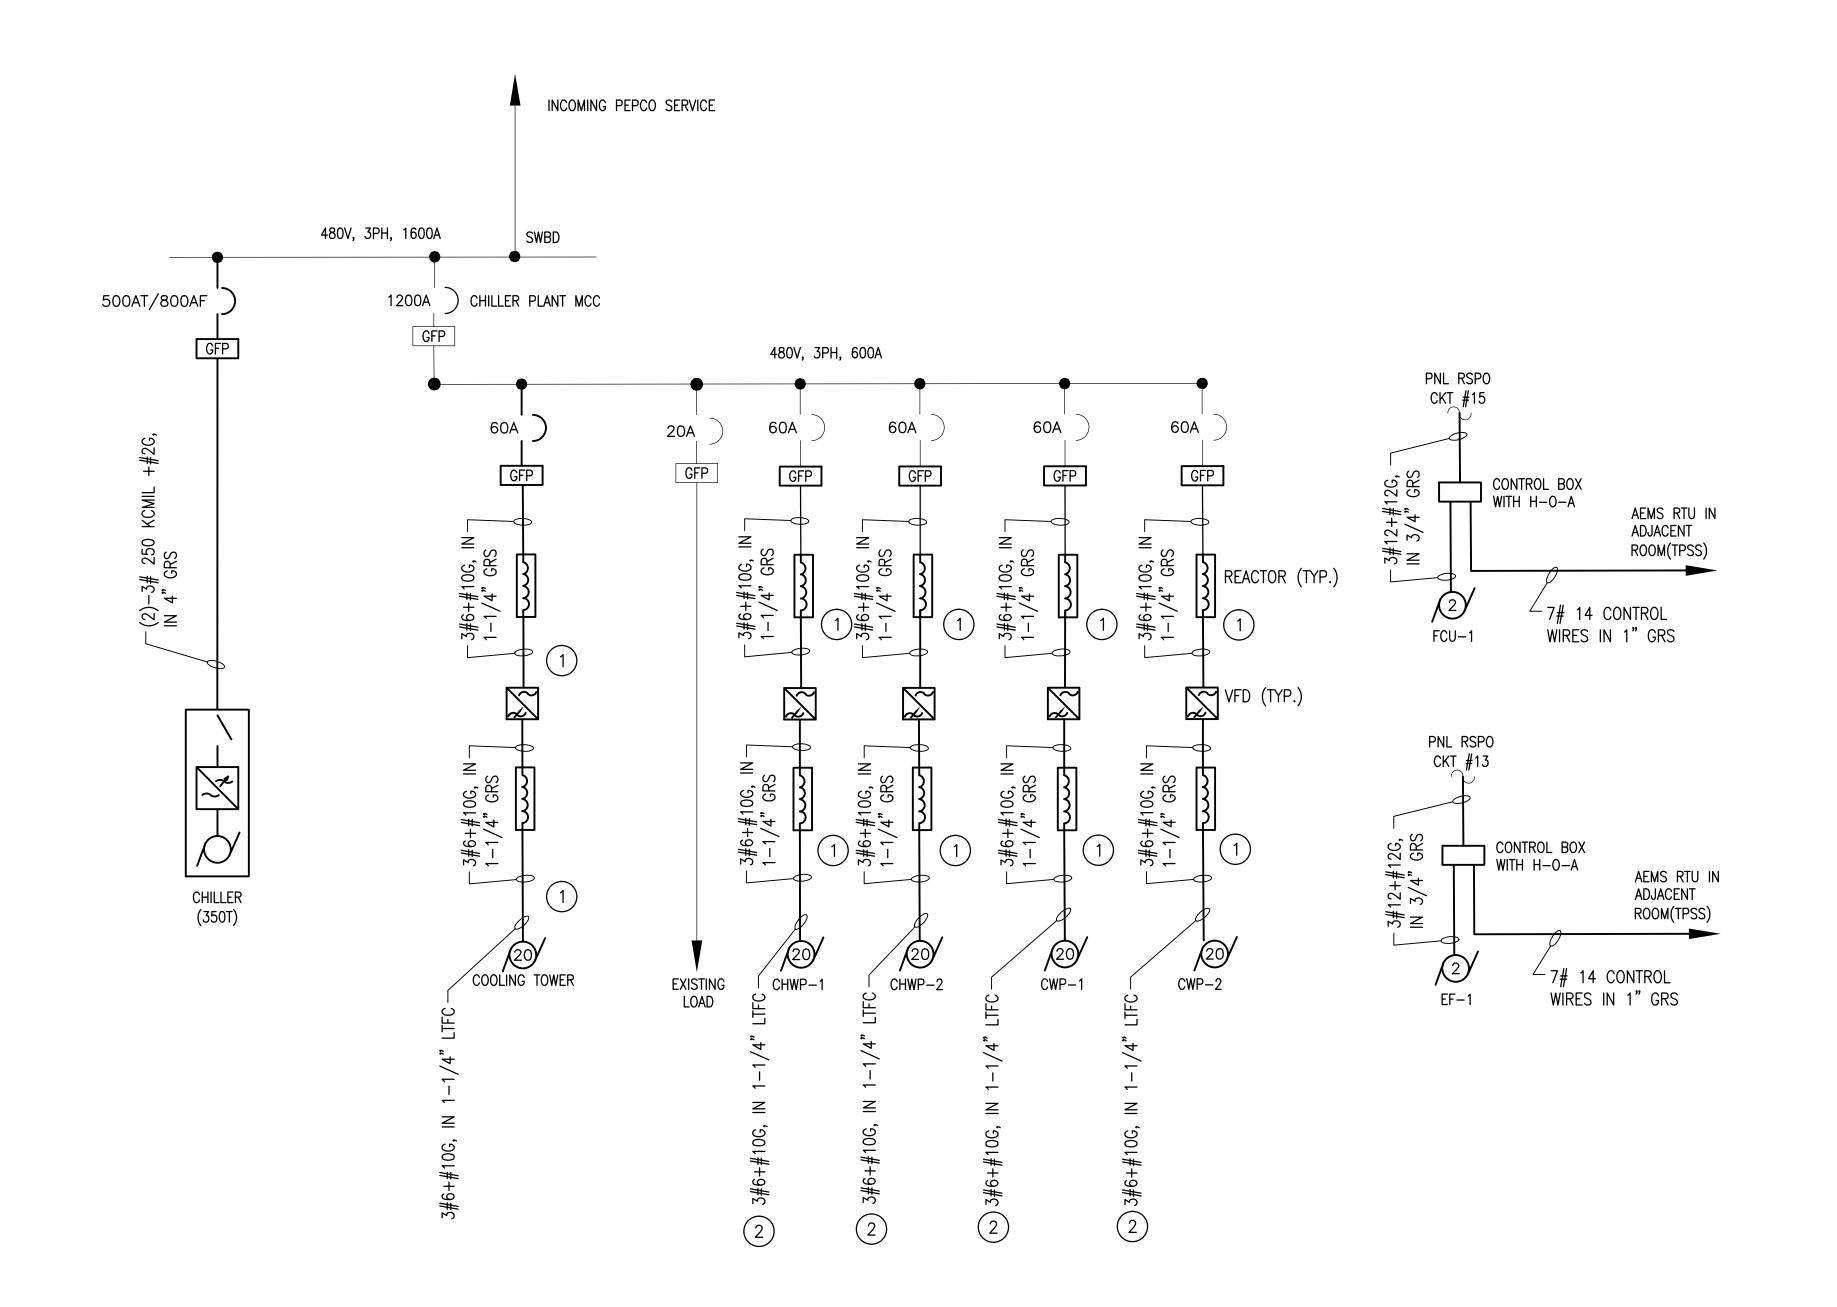

ELECTRICAL SINGLE LINE DIAGRAM - NEW WORK



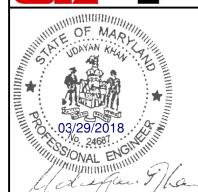

SHEET NOTES:

PLAN NOTES:

1. PROVIDE NEW CIRCUIT BREAKER WITH GROUND FAULT

LINE AND LOAD REACTORS FOR EACH VFD SHALL BE MOUNTED IN A SINGLE NEMA 4X ENCLOSURE

2 RUN NEW RGS FROM VFD AND STOP AT CONVENIENT PLACE NEAR MOTOR. CONTINUE WITH LTFC TO MOTOR.

PROTECTION IN EXISTING MCC.

State of Maryland Professional Certification. I hereby certify that these documents were prepared or approved by me, and that I am a duly licensed professional engineer under the laws of the State of Maryland, License No. 024687, Expiration Date: 03/15/2020

	REFERENCE DRAWINGS		REVISIONS	M WASHINGTON ME	TROPOLIT	AN AREA TRANSIT AUTHO	RITY			REPLACEME	NT OF CHILLERS	
DESIGNED B. IDILBI 09/30/17	NUMBER TITLE	DATE NUM 03/30/2018 0	DESCRIPTION FINAL CONTRACT DRAWINGS	metro VVASIIINGI ON IVIL	THOI OLII		/	AND	COOLING TO	OWER ACCESSOF	RIES AT EIGHT METRO-R	AIL STATIONS
DRAWN <u>J. ZHU</u> <u>09/30/17</u>						CONSTRUCTION SERVICES					ΓOL HEIGHTS (G02)	
DATE CHECKED <u>D. KHAN</u> 03/23/18				OFFICE OF INFRAST	RUCTURE F	RENEWAL PROGRAM GROUP			ELEC	TRICAL SINGLE LI	NE DIAGRAM - NEW WO	RK
DATE				APPROVED Mark H. IT lagrusser	03/2018	APPROVED Me Sle	03/2018	M NO.	CONTRACT NO.	SCALE	DRAWING NO.	SHEET NO.
				MARK MAGNUSSEN MANAGER, ENV. PLANNING AND COMP	DATE	GRAHAM SPILLER GFP DEPUTY PROGRAM MANAGER	DATE	M1304	FQ-18102	AS NOTED	CWPG2-E-602	129 of 173

										PA	NEL:R	SPA							MOT 600
MAIN BUS: 100A				MAIN	DEVI	CE: 5	AC									ı	NEUTRA	L BUS: 100%	
208/120 VOLT				3 PH	ASE,	4 W	IRE +	GROU	JND							1	RMS AIG	C: 10,000A	050
ENCLOSURE: NEMA 1				MOUN	ITING:	SUR	FACE									l	LOCATIO	ON: ADJACENT TPSS ROOM	SEC.
LOAD	LOAD	l w	IRE	RCWY	C,	/B	СКТ	PH	HASE K		CKT	C,	/B	RCWY	WIF	RE	LOAD	LOAD	
DESCRIPTION		_	•	SIZE	_	PL	NMBR	Α	В	С	NMBR	PL	TRIP	SIZE	GND	СКТ		DESCRIPTION	
S. WALL FIRST FL CONVEN OUT	300	12	12	3/4"	30	1	1	1300			2	1	20	3/4"	10	10	1000	CHILLER PLT CONVEN. OUT	$\left\{ \begin{array}{c} 1 \end{array} \right.$
RECT RM COLUMN CONVEN.OUT	_			3/4"		1	3	1.000	600		4	1	20	3/4"	12	12		CHILLER PLT CONVEN. OUT	1
RECT RM COLUMN CONVEN.OUT	200	_	_	3/4"		1	5			1200		1		3/4"				CHILLER PLT CONVEN. OUT	1 -
E.WALL AC S/B RM.CPNVEN.OUT	_			3/4"	20	1	7	1000			8	1		3/4"				W.WALL.AC S/B RM.CONVEN.OUT	1
TRANSF. ROOF CONVEN. OUT.	700			3/4"	20	1	9		700		10	1		3/4"				W.WALL.AC S/B RM.CONVEN.OUT	
GFI TEST	700	12	12	3/4"	20	1	*			700	12	1	20	-	-	-		CHEMICAL PLT ROOF EXH FAN	
CHILLER ROOF CONVEN. OUT.	700	-	-	_	20	1	11	1200			14	1	20	ı	_	_		AC S/B ROOF EXH FAN]
GFI TEST	1000	_	_	_	20	_	*		1000		16	1	20	ı	-	-	-	CHEMICAL FEED PUMP]
CHILLER COMP. OIL PUMP	_	_	_	_	_	-	13				17	1	_	1	_	-	-	ROLL UP ROOM CHILLER ROOM	<u> </u>
ATC. CONTROL PNL SUPPLY	_	_	_	_	_	_	15				18	1	_	_	_	_	_	ROLL UP ROOM DC.RECT. ROOM]
ATC S/G CUBICLE HEATERS	_	_	_	_	_	_	19				20	1	_	_	_	_	_	CONTROL PANEL]
SPARE		_	_		_	_	21				22	1	_	_	_	-		EXISTING LOAD] [
CONTROL	_	_	_		_	_	23				24	1	_	_	_	_		EXISTING LOAD	1
EXISTING LOAD	_	12	12	3/4"	20		25				26	1	-	-	-	-	_	EXISTING LOAD	
EXISTING LOAD	_	12	12	3/4"	20		27				28	1	-	_	_	_	_	EXISTING LOAD	†
EXISTING LOAD	-	12	12	3/4"	20		29				30	1	_	ı	-	-	-	EXISTING LOAD	
EXISTING LOAD	1	12	12	3/4"	20		31			140	32	1	_	ı	-	_	1	XFMR #4 CNTR HTR(AC-14)	
EXISTING LOAD	_	12	12	3/4"	20		33				34	1	_	ı	-	-	-	XFMR #1 CNTR HTR(AC-15)	
EXISTING LOAD	-	12	12	3/4"	20		35				36	1	-	I	-	-	_	XFMR #2 CNTR HTR(AC-16)	
EXISTING LOAD	1	_	_	_	_	ı	37				38								
INVERTER HEATER	1	-	_	_	1	-	39				40	3	50	_	-	_	_	RSPA1 NOTES 2&3	NOTE 1
AC SWGR HEATER (AC-9)	_	_	_	_	20		41				42								<u> </u>
NOTES:													CONN	IECTED	LO.	AD:	9,812	ZVA	1
NOTES:																	812VA		1

										PA	NEL:R	SP0						
MAIN BUS: 100A 480/277 VOLT ENCLOSURE: NEMA 1		MAIN DEVICE: 50A 3 PHASE, 4 WIRE + GROUND MOUNTING: SURFACE											NEUTRAL BUS: 100% RMS AIC: 10,000A LOCATION: ADJACENT TPSS ROOM					
LOAD	LOAD		_	RCWY	_	/B	CKT		HASE K		CKT	_	_	RCWY	_		LOAD	LOAI
DESCRIPTION	VA	CKT	GND	SIZE	TRIP	PL	NMBR	Α	В	С	NMBR	PL	TRIP	SIZE	GND	CKT	VA	DESCRIPTIO
SPARE	_	_	_	-	20	3	1	-	-	_	2	3	20	3/4"	12	12	600	UNIT HEATE
AIR COMPRESSOR	700	12	12	3/4"	20	3	3	_	_	-	4	3	20	3/4"	12	12	-	PANEL RSF
SPARE	_	_	_	-	20	3	5	-	-	_	6	3	20	3/4"	12	12	-	UNIT HEATI
JNIT HEATER	_	12	12	3/4"	20	3	7	П	-	-	8	3	20	3/4"	12	12	-	UNIT HEATE
UNIT HEATER	-	12	12	3/4"	20	3	9	ı	-	/ I	10	3	20	3/4"	12	12	-	UNIT HEATE
JNIT HEATER	_	12	12	3/4"	20	3	11	_	-	ı	12	3	20	3/4"	12	12	-	ISO XFER IT-
EVIIALICT FAN. /FF 4)	_	12	12	3/4"	20	3	13	-	_		14	1	20	_	_	_	_	SPA
EXHAUST FAN (EF-1)				5, 1	20		13			_	16	3	20	_	-	–	_	SPA
UNIT (FCU) FOR COOLING	_	12	12	3/4"	20	3	15	_	-	_	20	1	<u>-</u>	 	<u>-</u>	<u>-</u>	 	SPAI SPAI
NOTES:														IECTEI ND LO			– VA VA	

1			ENTER: 77V, 3ø,		R RND BUS			AVAILAB	ON: CHILLER PLANT BLE SHORT CIRCUIT: 2 BURE TYPE: NEMA 12	8,000 AMPS RMS SYM	
SEC.	ITEM		UIT BRE		MCP CONTIN.	CONNECTED	HP	DESCRIPTION	CONTROL DIAGRAM	E	ELEVATION
NO.	NO.	POLES	FRAMES AMP.	TRIP AMP.	RATING AMP.	LOAD KVA	OR KW		DWG NO.	SECTION 1	SECTION 2
	1A	3	1200	1200	-	_	_	MAIN LUGS			
	1B	3	100	60	-	1	20HP	CHILLER WATER PUMP			
1	1C	3	100	60	-		20HP	CHILLER WATER PUMP] 1A	2A
	1D	_	-	-	_	1	_	SPACE			
	1E	3	100	60	_	_	20HP	COOLING TOWER FAN FEEDER		1B	2B
	2A	3	100	60	_	-	20HP	CONDENSER WATER PUMP			20
	2B	3	100	60	_	1	20HP	CONDENSER WATER PUMP		1C	2C
2	2C	3	100	20	_	1	_	EXISTING LOAD			
	2D	_	_	_	_	_	_	SPACE		1D	2D
	2E	_	_	-	_	_	-	SPACE			2E
	2F	_	_	-	-	_	1	SPACE		1E	2F
										MANUFACTURER: CULTE	R-HAMMER OM SERIES 2100

NOTE 3 PANEL: RSPA1 MAIN BUS: 100A NEUTRAL BUS: 100% MAIN DEVICE 50A 208/120 VOLT 3 PHASE, 4 WIRE + GROUND RMS AIC: 10,000A ENCLOSURE: NEMA 1 MOUNTING: SURFACE LOCATION: ADJACENT TPSS ROOM LOAD WIRE RCWY C/B CKT PHASE KVA CKT C/B RCWY WIRE LOAD LOAD VA CKT GND SIZE TRIP PL NMBR A B C NMBR PL TRIP SIZE GND CKT VA DESCRIPTION DESCRIPTION CHILLER PLANT MONITORING REFRIGERANT LEAK DETECTION FLOW MONITORING PANEL 12 12 3/4" 20 1 3 4 1 20 3/4" 12 12 - INSTANTANEOUS WATER HEATER UTILITY SINK WITH WATER HTR 12 12 3/4" 20 1 1 5 6 | 1 | 20 | - | - | - | - | SPARE _ | _ | _ | _ | 20 | 1 | 7 SPARE 8 1 20 - - - SPARE 10 1 20 - - - SPARE - |- |- | 20 | 1 | 9 SPARE - |-|-| - |20 | 1 | 11 - | 12 | 1 | 20 | - | - | - | SPARE CONNECTED LOAD: -VA NOTES:

		ELECTRICAL EQUIPMENT SCHEDULE
ITEM	QTY	DESCRIPTION
1	5	MCC BUCKET TO MATCH EXISTING WITH 60AT/100AF BREAKER
2	10	REACTOR/FILTER 480V, 3PH, 27A, 20HP, 60HZ, NEMA 4X ENCLOSURE
3	5	VFD,480V, 3PH, 20HP, 60HZ, NEMA 4X ENCLOSURE WITH BYPASS AND REACTOR/FILTERS
4	LOT	#2 AWG RHW-2 WIRE (GND)
5	LOT	#6 AWG RHW-2 WIRE (VFD RATED)
6	LOT	#6 AWG RHW-2 WIRE
7	LOT	#10 AWG RHW-2 WIRE (GND)
8	LOT	#12 AWG RHW-2 WIRE
9	LOT	#12 AWG RHW-2 WIRE (GND)
10	LOT	250 KCMIL RHW-2 WIRE
11	LOT	3/4" GRS CONDUIT
12	LOT	1" GRS CONDUIT
13	LOT	1-1/4" GRS CONDUIT
14	LOT	1-1/4" LTFC
15	LOT	4" GRS CONDUIT
16	1	3P, 50A MCB (RSPA1 FEEDER)
17	1	3P, 4 WIRE, 100A, 208/120V DISTRIBUTION PANEL(RSPA1) 12CKTS, 50A MAIN DEVICE.
18	1	SWBD POWER CIRCUIT BREAKER TO MATCH EXISTING 500AT/800AF

	SHEET	NOTES
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38, 40 &42.

- 1. RELOCATE CKT 38 AND ITS LOAD TO BUSSED SPACE
- 2. INSTALL 3 POLE, 50A CKT BREAKER IN BUSED SPACES
- 3. INSTALL NEW DISTRIBUTION PANEL RSPA1, 208/120V, 12 CKTS.
- 4. IN PANEL RSPO INSTALL 2-3 POLE, 20A CIRCUIT BREAKERS IN POSITION #13, # 15 AND WIRE THEM TO EF-1 CONTROL BOX AND FCU-1 CONTROL BOX.

	A Gannett Fleming/Parsons JOINT VENTURE
OF MAR 1997 OF MA	State of Maryland Professional Certification. I hereby certify that these documents were prepared or approved by me, and that I am a duly licensed professional engineer under the laws of the State of Maryland, License No. 024687, Expiration Date: 03/15/2020
REPLACEMENT OF CH	ILLERS

				REFERENCE DRAWINGS	REVISIONS				
DEGIONED B	3. IDILBI	09/30/17	NUMBER	TITLE	DATE	NUM	DESCRIPTION	1	
DESIGNED <u>B.</u>	<u>. IDILDI</u> .	DATE			03/30/2018	0	FINAL CONTRACT DRAWINGS	\vdash	
DRAWN <u>J.</u>	J. ZHU	09/30/17	<u> </u>			<u>'</u>			
		DATE	<u> </u>			<u>'</u>		-	
CHECKED <u>D.</u>	D. KHAN	03/23/18				<u>'</u>		-	
_		DATE	<u> </u>			<u>'</u>		ļ <i>þ</i>	
			<u> </u>			<u> </u>		<u> </u>	
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NOTE 4

NOTE 4

WASHINGTON METROPOLITAN AREA TRANSIT AUTHORITY


DEPARTMENT OF DESIGN AND CONSTRUCTION SERVICES


OFFICE OF INFRASTRUCTURE RENEWAL PROGRAM GROUP **GRAHAM SPILLER** MANAGER, ENV. PLANNING AND COMP GFP DEPUTY PROGRAM MANAGER

03/2018 DATE

AND COOLING TOWER ACCESSORIES AT EIGHT METRO-RAIL STATIONS CWPG2 - CAPITOL HEIGHTS (G02) ELECTRICAL FOUIPMENT AND PANEL SCHEDULE

	ELECTRICAL EQUIPMENT AND PANEL SCHEDULE											
M NO.	CONTRACT NO.	SCALE	DRAWING NO.	SHEET NO.								
M1304	FQ-18102	AS NOTED	CWPG2-E-603	130 of 173								

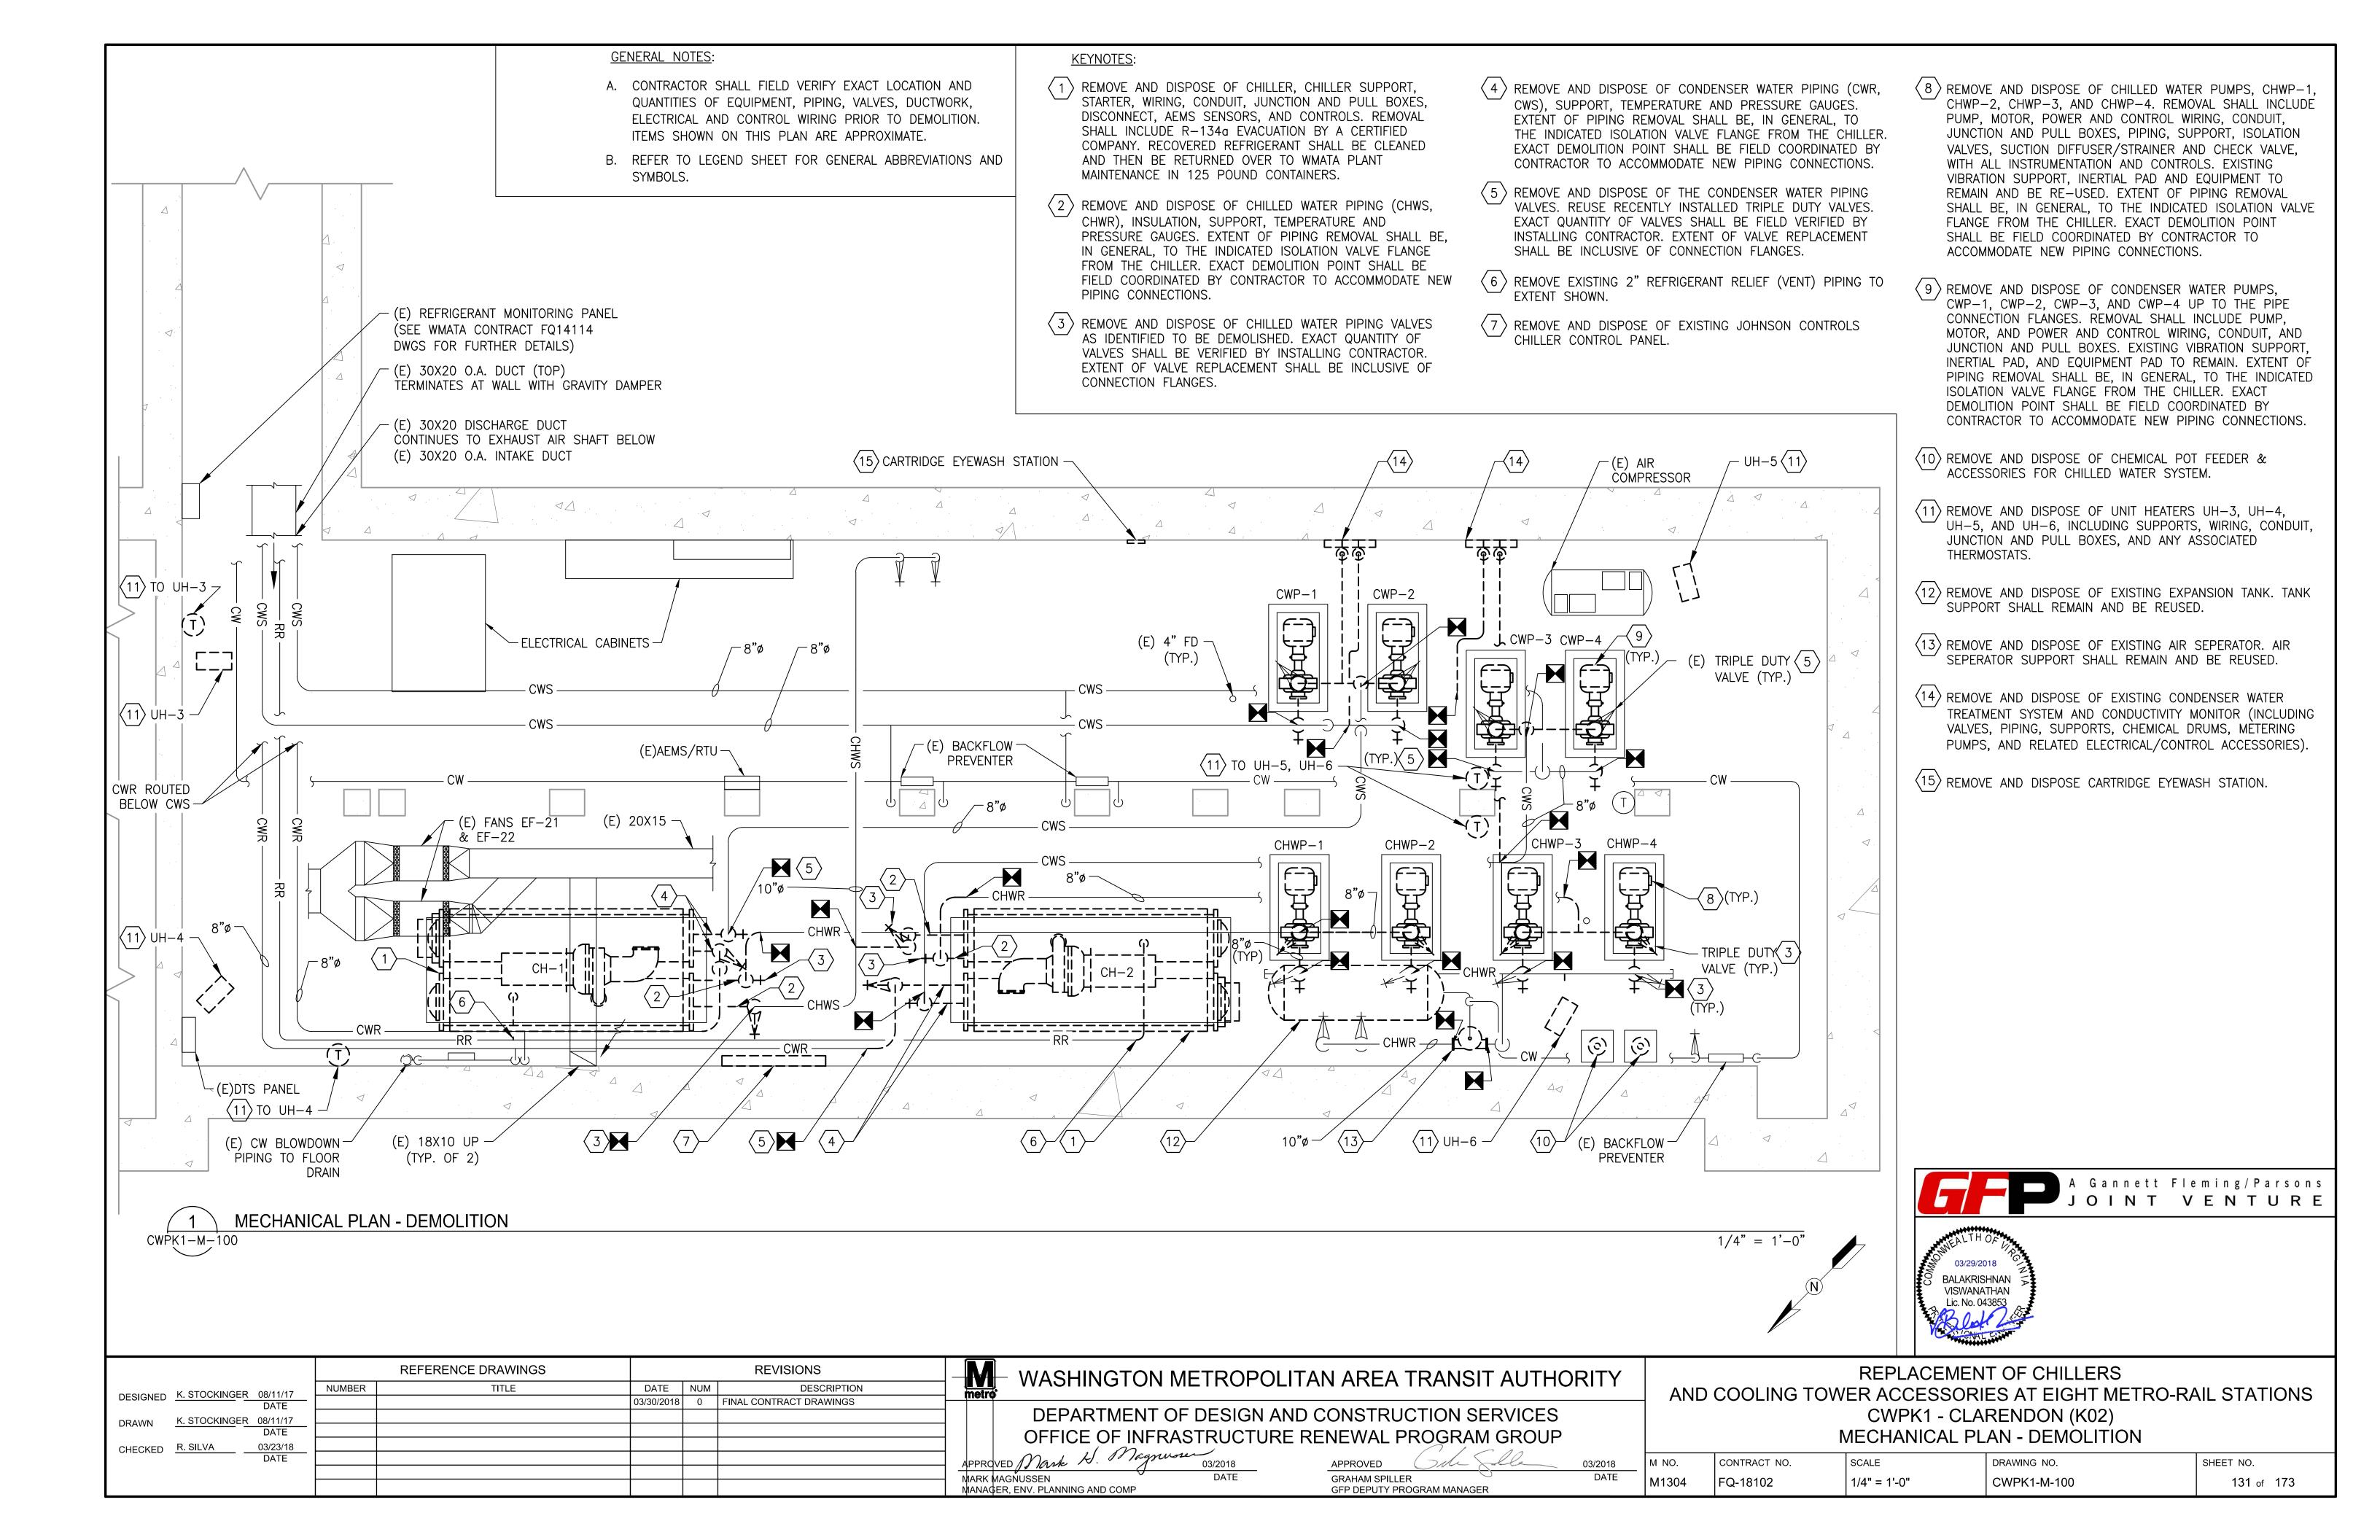

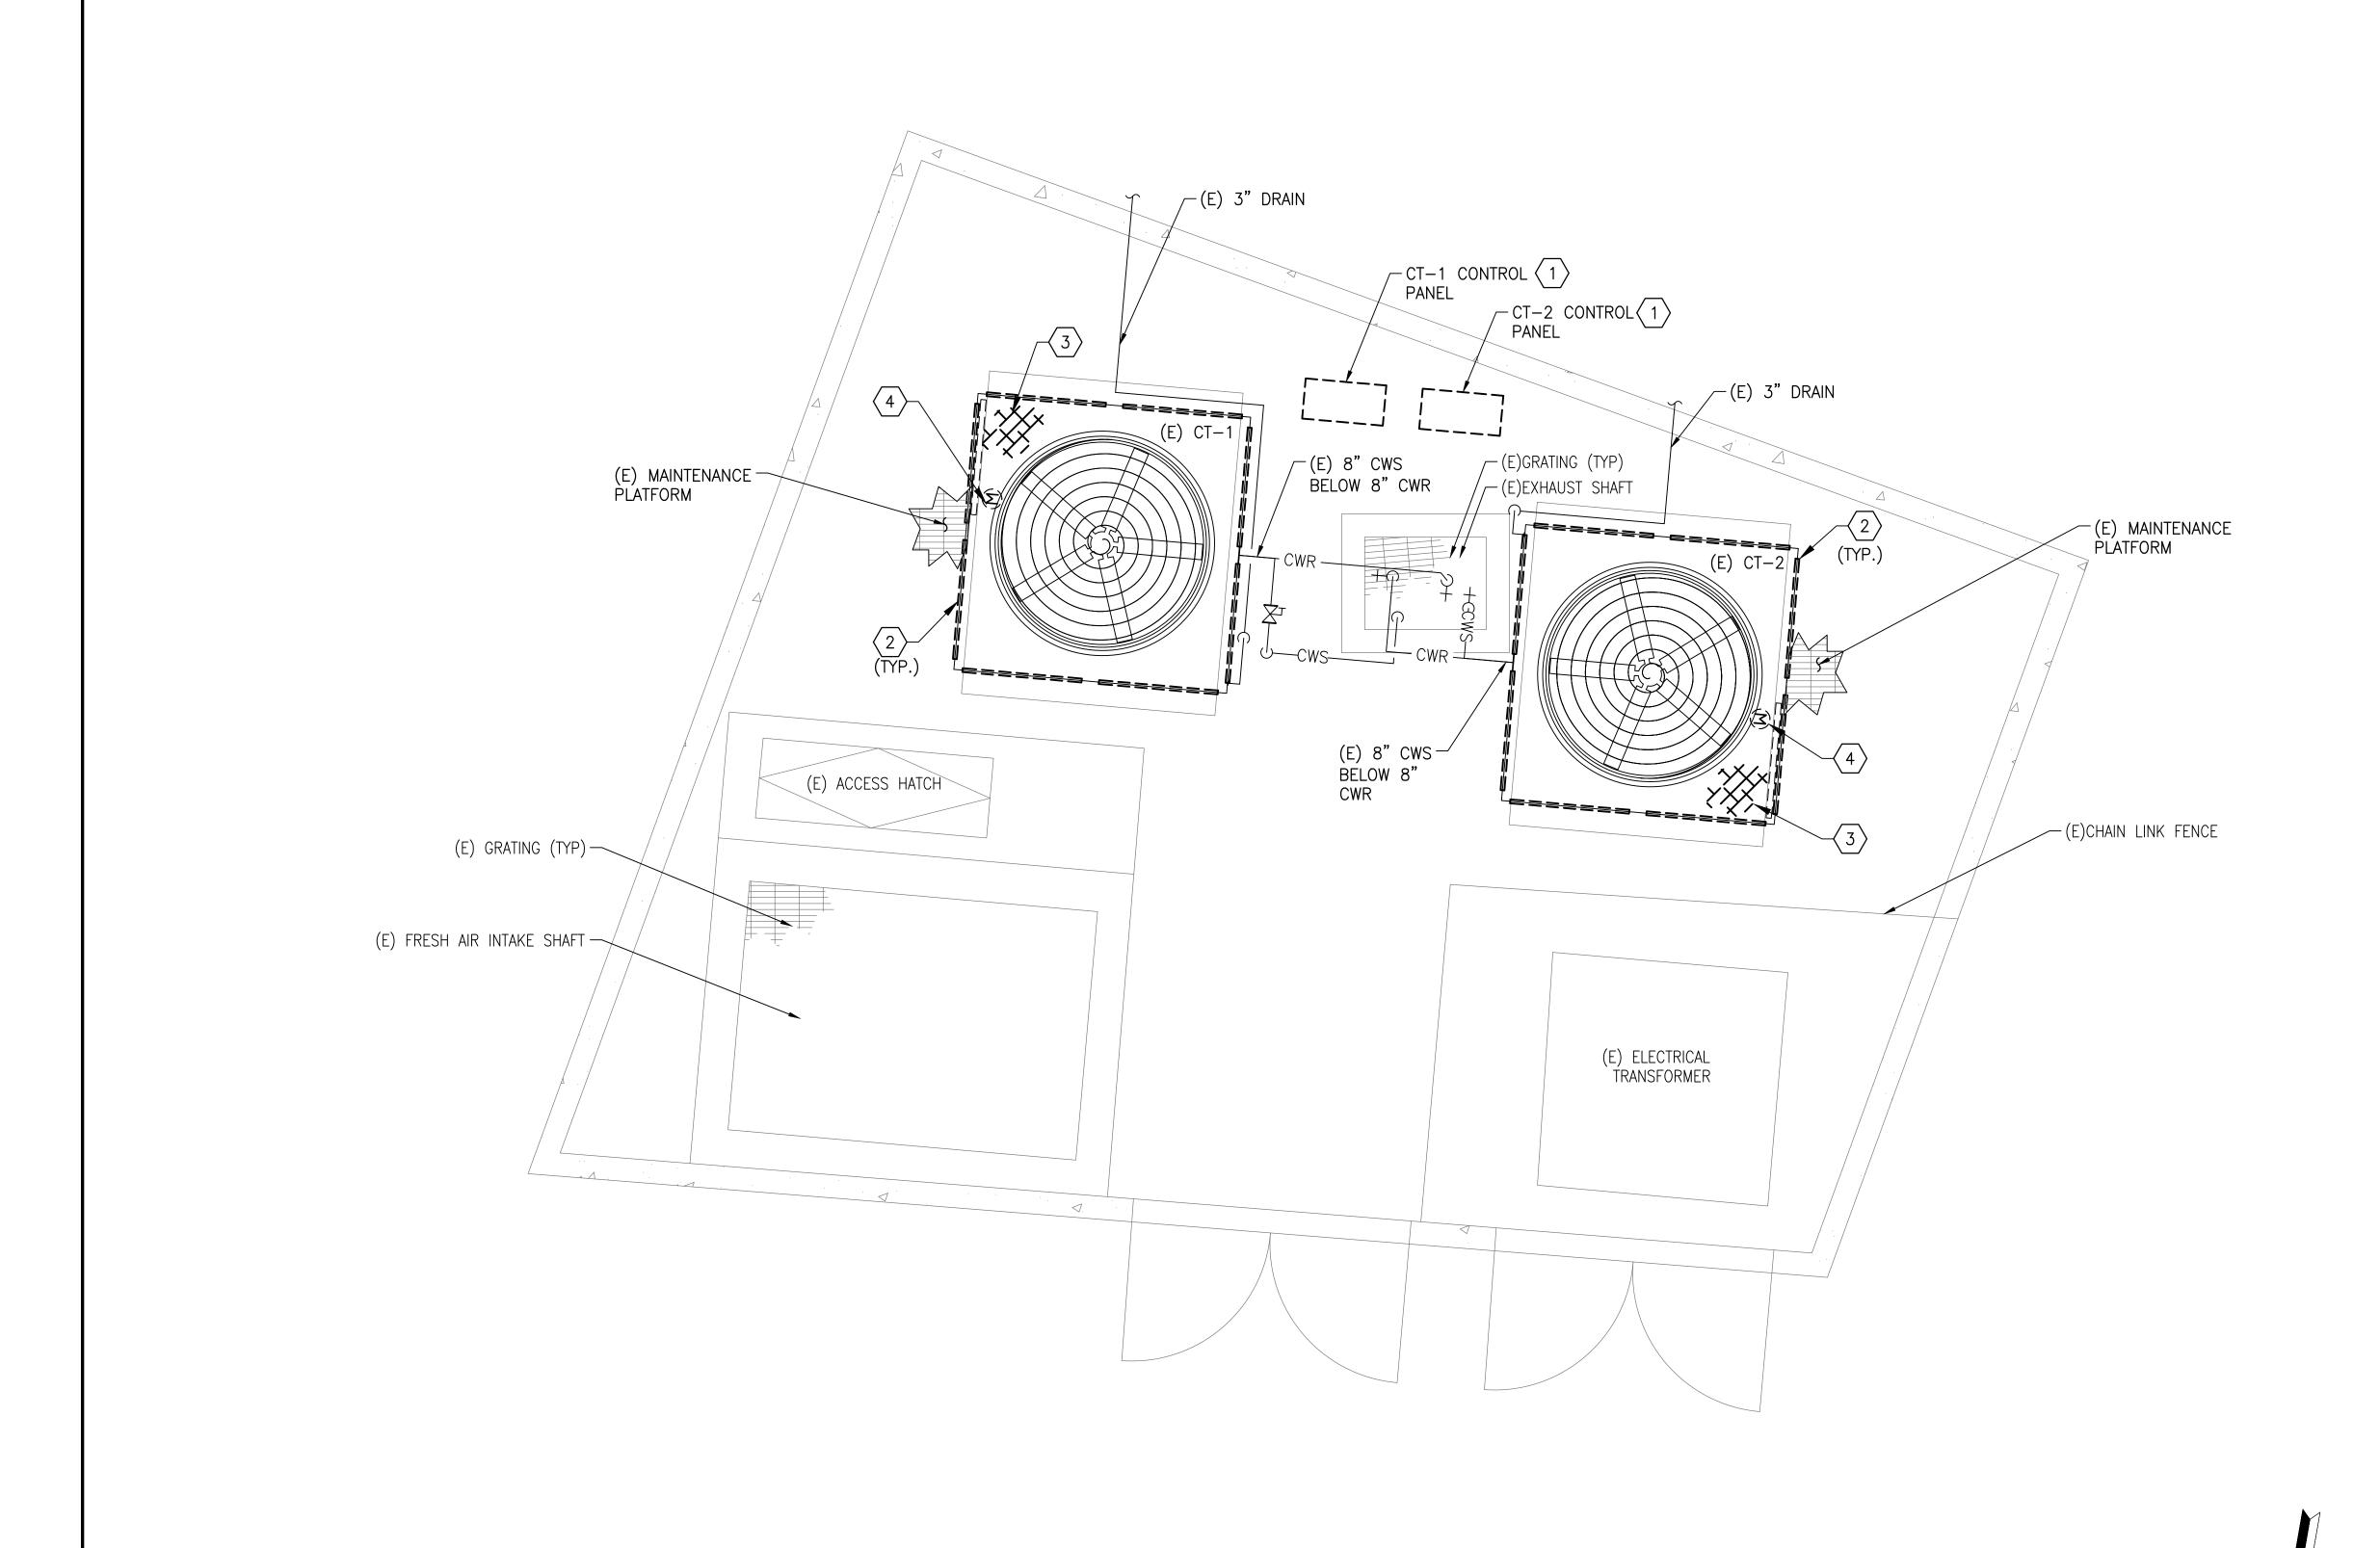


GENERAL NOTES:

- A. CONTRACTOR SHALL FIELD VERIFY EXACT LOCATION AND QUANTITIES OF EQUIPMENT, PIPING, VALVES, DUCTWORK, ELECTRICAL AND CONTROL WIRING PRIOR TO DEMOLITION. ITEMS SHOWN ON THIS PLAN ARE APPROXIMATE.
- B. REFER TO LEGEND SHEET FOR GENERAL ABBREVIATIONS AND SYMBOLS
- C. COOLING TOWERS LOCATED AT GRADE LEVEL AT 2750 CLARENDON BLVD.
- D. ALL COOLING TOWER COMPONENTS THAT ARE REMOVED ARE TO BE REPLACED IN KIND. INSTALLING CONTRACTOR SHALL COORDINATE WITH COOLING TOWER MANUFACTURER PRIOR TO REMOVAL.

KEYNOTES:

- 1 REMOVE COOLING TOWER FAN STARTER, DISCONNECT, AND CONTROLLER.
- 2 REMOVE AND DISPOSE OF EXISTING LOUVER ON COOLING TOWER.
- REMOVE AND DISPOSE OF EXISTING FILL, IN THE COOLING TOWER.
- 4 REMOVE EXISTING FAN MOTOR, BELT DRIVEN FAN DRIVE ASSEMBLY, BELTS, SHEAVES, AND MOUNTING HARDWARE.



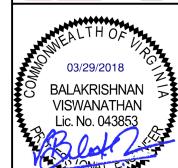

1 MECHANICAL PLAN - DEMOLITION CWPK1-M-101

SCALE: 1/4" - 1'-0"

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me
APP
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WASHINGTON METROPOLITAN AREA TRANSIT AUTHORITY

DEPARTMENT OF DESIGN AND CONSTRUCTION SERVICES OFFICE OF INFRASTRUCTURE RENEWAL PROGRAM GROUP

MARK MAGNUSSEN DATE
MANAGER, ENV. PLANNING AND COMP

APPROVED 03/2018

GRAHAM SPILLER DATE

GFP DEPUTY PROGRAM MANAGER

REPLACEMENT OF CHILLERS
AND COOLING TOWER ACCESSORIES AT EIGHT METRO-RAIL STATIONS
CWPK1 - CLARENDON (K02)
MECHANICAL PLAN - DEMOLITION

WEST IN COLUMN DEWISE THOM					
NO.	CONTRACT NO.	SCALE	DRAWING NO.	SHEET NO.	
11304	FQ-18102	1/4" = 1'-0"	CWPK1-M-101	132 of 173	

